

NATIONAL SENIOR CERTIFICATE

GRADE 12

ENGINEERING GRAPHICS AND DESIGN P1 NOVEMBER 2022

MARKS: 100

TIME: 3 hours

This question paper consists of 6 pages.

	Barcode label	
1		

INSTRUCTIONS AND INFORMATION

- 1. This question paper consists of FOUR questions.
- 2. Answer ALL the questions.
- 3. ALL drawings are in first-angle orthographic projection, unless otherwise stated.
- 4. ALL drawings must be prepared using pencil and instruments, unless otherwise stated.
- 5. ALL answers must be drawn accurately and neatly.
- 6. ALL the questions must be answered on the QUESTION PAPER, as instructed.
- 7. ALL the pages, irrespective of whether the question was attempted or not, must be re-stapled in numerical sequence in the TOP LEFT-HAND CORNER ONLY.
- 8. Time management is essential in order to complete all the questions.
- 9. Print your examination number in the block provided on every page.
- 10. Any details or dimensions not given must be assumed in good proportion.

FOR OFFICIAL USE ONLY															
QUESTION	MARK	(S OBT	AINED	<u>1</u>	SIGN	МО	DERAT	ED	1/2	SIGN	RE-	-MARKI	NG	<u>1</u>	SIGN
1															
2															
3															
4															
TOTAL															
	2	0	0			2	0	0			2	0	0		

•	
FINAL CONVERTED MARK	CHECKED BY
100	

COMPLETE THE FOLLOWING:
CENTRE NUMBER
CENITRE NUMBER
EXAMINATION NUMBER
EXAMINATION NUMBER

Engineering Graphics and Design/P1 NSC DBE/Movember 2022

LAND SURVEYOR'S CERTIFICATE OF THE CORNER HEIGHTS AND BOUNDARY LENGTHS OF STAND 3414						
	ER HEIGHTS METRES		DARY LENGTHS MILLIMETRES			
Α	1600	AB	24230			
В	1600	вс	8370			
С	1599	CD	18380			
D	1599	DE	31200			
E	1601	EA	32400			

SYMBOL LEGEND				
	EVERGREEN Trees			
0	BUSHES			
-x x	2000 HIGH SECURITY FENCE			
	1800 H∎GH PALL∎SADE FENICE			

NI3 NIATIONAL ROAD 15 m ROAD RESERVE MH 3600 BL EXISTING SEWERAGE LINE STINKWOOD LANE PROPOSED NEW STAND 3414 EXTENSION DRAWING TITLE: 2 (3) 2500 BL STAND 3413 3,6 m WIDE VEHICLE ENTRY DOMBEYA STREET SITE PLAN SCALE 1:350


NOTE:

Contractors must verify all dimensions and levels on site before commencing work. Architects to be notified immediately of any discrepancies.

ARCHITECT'S SIGNATURE

ANSWER 18

In the space below, draw, in neat freehand, the *SANS 10143* hatching (symbol) for a (18.1) FACE BRICK WALL, and graphical symbol for a (18.2) STAIRCASE.

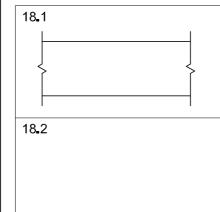

2	07/01/22	Α	L I SA B			
1	06/01/22		DLOUR NE	L I SA B		
REVISION	DATE	DESCRIPTION DRAV				
KOMBELLA, JOUBERT & MINNAAR ARCHITECTURAL DESIGNI 365 BORCHARDS AVENUE ERASMIA 0183 012 685 1857 www.kjmdesign.co.za						
PRINTED BY:			DATE OF PRINT:			
STEVENS PRINTERS			08/01/2022			

SITE PLAN PROJECT:

PROPOSED NEW ADDITION FOR MR N KEENAN ON STAND 3414, 21 DOMBEYA STREET, HARRISMITH

PROJECT NUM	IBER:	DRAWING NUMBER:				
FTW	/2022 - 59	1 OF 5				
DATE:	DRAWNI:	CHECKED:	SCALE:			
05/01/2022	CASPER	ANNIE Q	1:350			
REFERENCE C	ODE: -2022					

QUESTION 1: ANALYTICAL (CIVIL)

Given:

The site plan of an existing house with a proposed new extension, a title panel and a table of questions. The drawing has not been presented to the indicated scale.

Instructions:

Complete the table below by neatly answering the questions, which refer to the accompanying drawing, title panel and civil content. [30]

g	QUESTIONS ANSWER					
	1	What does the number FTW2022-59 refer to?	1			
	2	Who is the client?	1			
	3	What is the title of the drawing?	1			
	4	What action was taken on 08/01/2022?	1			
	5	Who was responsible for preparing the revisions to the drawing?	1			
	6	How wide is the road reserve in millimetres?	1			
+	7	Whose signatures are required on the site plan?	2			
	8	How many new inspection eyes are shown on the site plan?	1			
	9	What does the abbreviation RWDP stand for?	1			
	10	Which corner of STAND 3414 is the highest?	1			
	11	Determine the shortest distance from the proposed new extension to boundary line AB in metres.	1			
	12	What is indicated in BLUE on floor plans and/or sections?	2			
۱В	13	Name the feature at 1.	1			
AВ	14	What is indicated by the arcs at 2?	1			
	15	Name the feature at 3.	1			
WN	16	What does the ratio 1:40 on the new sewerage line indicate?	1			
	17	Which elevation of the existing house faces the N3 national road?	2			
	18	In the space in the title panel (ANSWER 18), draw, in neat freehand, the SANS 10143 hatching (symbol) for a (18.1) FACE BRICK WALL, and graphical symbol for a (18.2) STAIRCASE.	4			
	19	In the space below (ANSWER 19), determine the total length of the 1800 high pallisade fence	3			
	13	required for STAND 3414, in metres.	3			
	20	In the space below (ANSWER 20), determine the total area of the house, including the new extension, in square metres. Show the answer to TWO decimal places.	3			
		TOTAL	30			

ANSWER 19 Show ALL calculations.

10800

ANSWER 20 Show ALL calculations.

EXAMINATION NUMBER

EXAMINATION NUMBER



QUESTION 2: SOLID GEOMETRY

Given:


- The front view and top view of a right square pyramid that rests against a right regular pentagonal prism
- An auxiliary view of the right square pyramid
- Cutting plane R-R

Instructions:

Draw, to scale 1:1, the following views of both solids:

- 2.1 The given front view
- 2.2 A sectional top view with the parts above cutting plane R-R removed
- 2.3 A sectional right view with the parts below cutting plane R-R removed
- 2.4 The true shape of the cut surfaces of BOTH solids
- Planning is essential.
- Show ALL hidden detail.
- Show ALL construction.

[37]

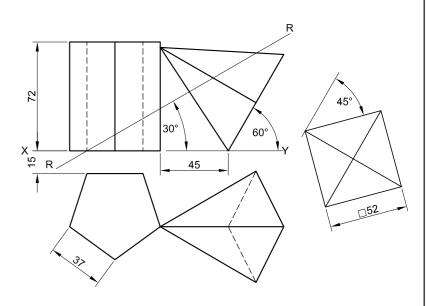

	ASSESSMENT CRITERIA					
1	FRONT VIEW	7				
2	SECTIONAL TOP VIEW	12 ½				
3	SECTIONAL RIGHT VIEW	10				
4	TRUE SHAPE	$6\frac{1}{2}$				
5	CORRECT HATCHING	1				
PENA	PENALTIES (=)					
	TOTAL 37					
EXAMINATION NUMBER						
	EXAMINATION NUMBER 3					

Three views of a dub house and the information needed to draw a two-point perspective drawing PP - Picture plane

QUESTION 3: PERSPECTIVE

Given:

HL - Horizon line

GL - Ground line

SP - Station point


Instructions:


Complete the perspective drawing.


- Align the drawing sheet with the ground line (GL)
- Determine and label the vanishing points.
- Show ALL construction.
- Show depth at the windows_
- NO hidden detail is required.

[41]


ASSESSMENT CRITERIA						
1	CONSTRUCTION	6				
2	WALL + BASE	10 ½				
3	WINDOWS + OPENING	10				
4	ROOF	7 ½				
5	ARC	7				
PEN	IALTIES (■)					
	TOTAL	41				

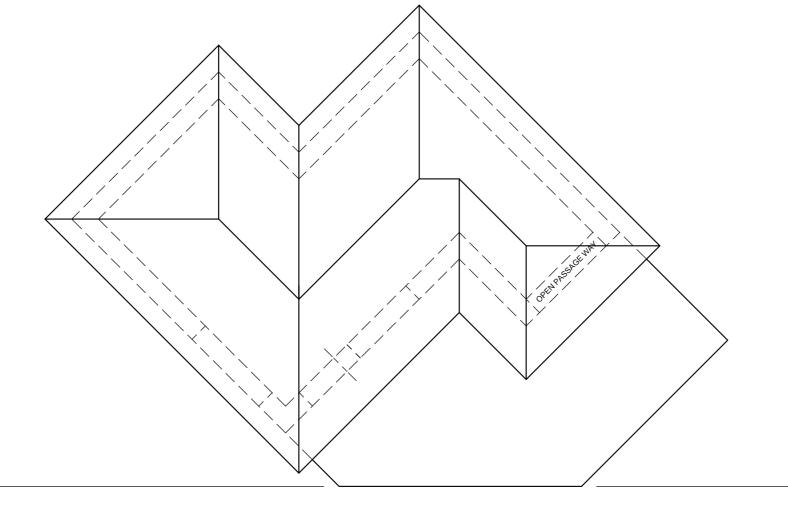

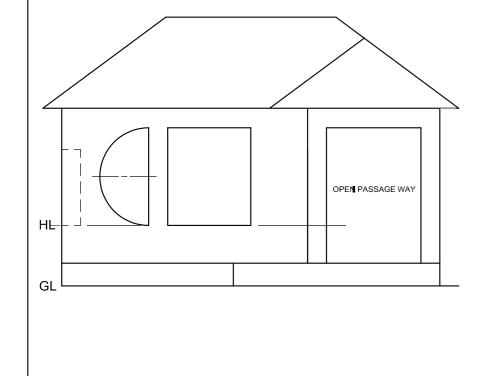

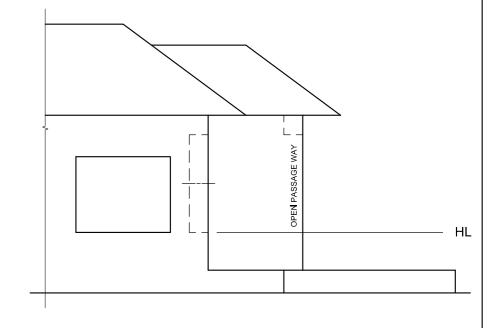

EXAMINATION NUMBER EXAMINATION NUMBER

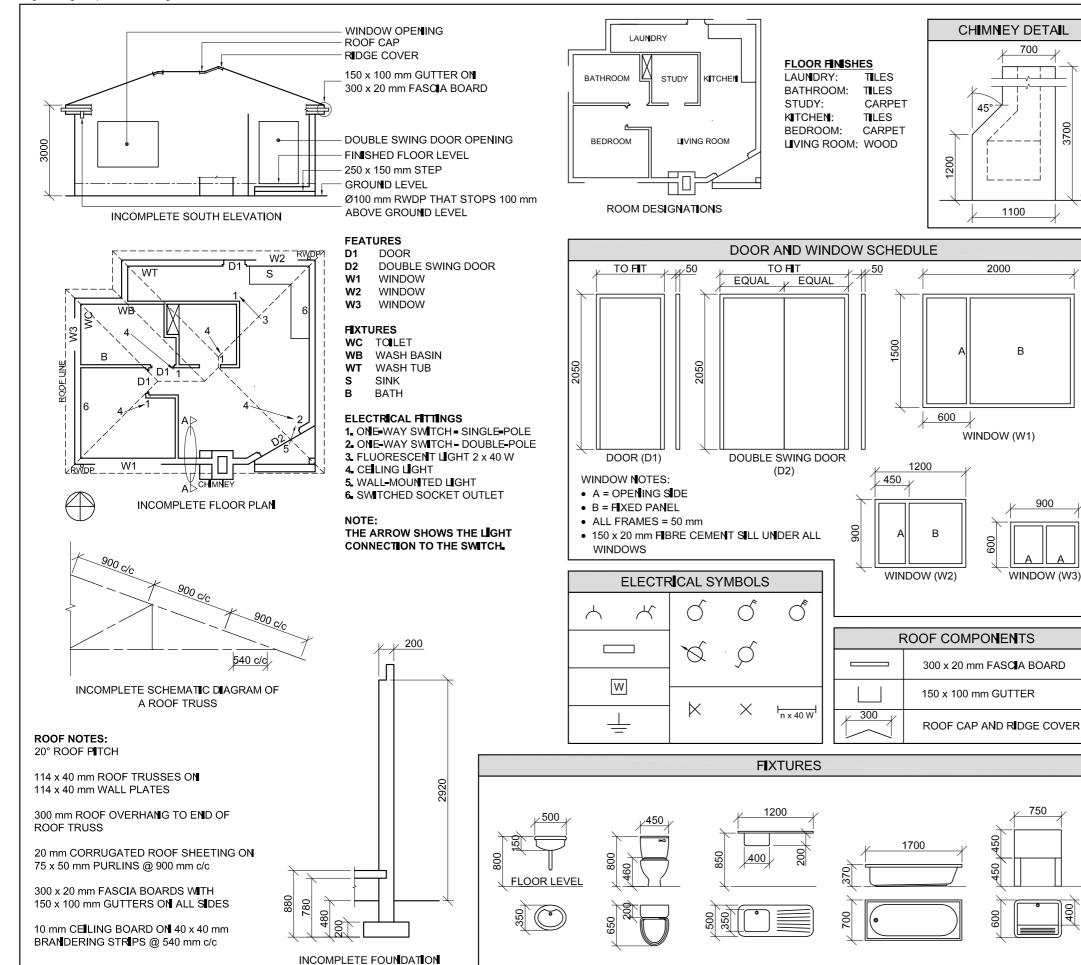

WASH BASIN

(WB)

TOILET

(WC)

SINK

(S)

BATH

(B)

AND EXTERNAL WALL DETAIL

QUESTION 4: CIVIL DRAWING

Given:

- The incomplete south elevation of a new house, showing the walls, window and double swing door openings, step, position of the chimney, roof and labels
- The incomplete floor plan showing the walls, step, positions of the doors, windows, chimney and fixtures, as well as electrical layout
- An incomplete schematic diagram of a roof truss and roof notes.
- The incomplete foundation and external wall detail
- Room designations and floor finishes
- A table with chimney detail
- A door and window schedule
- A table of electrical symbols
- A table of roof components
- A table of fixtures
- The incomplete floor plan and position of the ground level of the **new house**, drawn to scale 1:50, and the incomplete foundation and a break line for the detailed section, drawn to scale 1:20, on page 6.

Instructions: Answer this question on page 6.

4.1 Using the given incomplete floor plan and ground level, draw, to scale 1:50, the following views of the new house:

4.1.1 THE COMPLETE FLOOR PLAN

Add the following features to the drawing:

- ALL doors and windows
- ALL fixtures as indicated by the abbreviations
- ALL electrical fittings as indicated by the numbers
- ALL the roof lines
- ALL hatching detail

4.1.2 THE COMPLETE SOUTH ELEVATION Show the following features on the drawing:

- The outside walls, step, chimney, window and double swing door detail
- The roof detail, including the fascia boards, gutters and rainwater down-pipe
- The finished floor level
- 4.2 Using the given incomplete foundation and break line on page 6, draw, to scale 1:20, a **DETAILED SECTION** on cutting plane A-A of the area in the ellipse shown on the incomplete floor plan.

Show the following features on the drawing:

- The complete foundation and external wall detail
- The roof detail, including the fascia board and gutter
- The chimney and the double swing door and frame to the right (east) of cutting plane A-A
- ALL hatching detail. ONLY the substructure hatching may be drawn in neat freehand.

Label the following:

- The south elevation
- The floor finishes
- Ground level, finished floor level and damp-proof course (use the correct abbreviation and show it on ALL relevant views).


NOTE

WASH TUB

(WT)

All drawings must comply with the **guidelines** and **graphical symbols** as contained in the *SANS 10143*. [92]

5

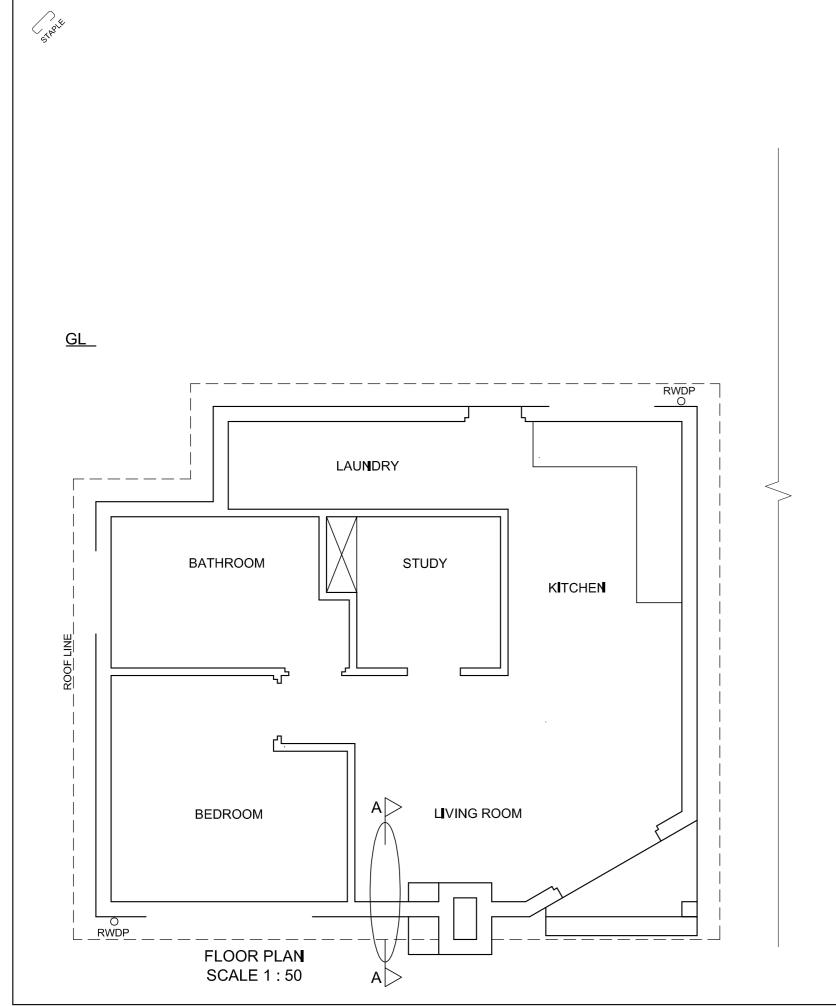

MARK ALLOCATION FOR	FOR OFFICIAL USE ONLY				
SECTION OF ROOF	INCORRECT SCALE(S)				
A	USED				
В	NON-ALIGNMENT OF VIEWS				
С	VIEWS				
D	MEW(S) ROTATED				
E	SECTION VIEWED INCORRECTLY				
F	INCORRECTET				
G	INCORRECT LETTERING				
Н					
TOTAL	TOTAL				

ASSESSMENT CRITERIA					
FLOOR PLAN					
		POSSIBLE	OBTAINED	SIGN	MODERATED
1	DOORS + WINDOWS	11			
2	FIXTURES + ROOF LINES	15			
3	ELECTR I CAL	10			
4	HATCHING	3			
5	LABELS	3			
SUBTOTAL		42			
SOUTH ELEVATION					
1	ROOF + RWDP	8 1 2			
2	WALLS + STEP + CHIMNEY + FFL	7			
3	DOOR + WINDOW	7			
4	LABELS	1			
SUBTOTAL		$23\frac{1}{2}$			
DETAILED SECTION					
1	ROOF DETAIL	11 ½			
2	SLAB + WALL + CHIMNEY	8			
3	HATCHING	3 1/2			
4	DOOR	2 ½			
5	LABELS	1			
SUBTOTAL		$26\frac{1}{2}$			
TOTAL		92			_
PENALTIES (-)					
GRAND TOTAL					
EXAMINATION NUMBER					
EXAMINATION NUMBER 6					
EXAMINATION NUMBER 6					

SECTION A-A

SCALE 1:20